

		60 VOLT SWITCHGEAR No. EVICE RATING SCHEDULE	
ITEM	CIRCUIT	DESCRIPTION	RATINGS
(1)		AUTOMATIC TRANSFER SWITCH MAIN BUS VOLTAGE RATING CURRENT RATING NEUTRAL SIZE & TYPE BUS BRACING	5 KV 1200A NONE 50KA SYM
n	1	IT RE/HL&P INCOMING MAIN CIRCUIT BREAKER QUANTITY 3 POLE — TYPE MOUNTING VOLTAGE RATING FRAME SIZE CONTINUOUS TRIP SETTING INTERRUPT CAPACITY	1 LOAD BREAK DRAWOUT 5 KV 1200A 600A 50KA SYM
	2 3	SWITCHEAR MAIN SWITCHES QUANTITY 3 POLE — TYPE MOUNTING VOLTAGE RATING FRAME SIZE CONTINUOUS FUSE SIZE INTERRUPT CAPACITY OPTIONS	2 LOAD BREAK FIXED 5 KV 1200A 600A 50KA SYM
(IV)	* 4 . 5	CENERATOR INCOMING MAIN CIRCUIT BREAKER  QUANTITY 3 POLE - TYPE MOUNTING VOLTAGE RATING FRAME SIZE CONTINUOUS TRIP SETTING INTERRUPT CAPACITY	1 AND 1 FUTURE LOAD BREAK FIXED 5 KV 1200A 300A 50KA SYM

	36"	J6"	36"	36"	36"	35"
	GENERATOR No.2 INCOMING SERVICE	GENERATOR NO.1 INCOMING SERVICE	GENERATOR CONTROLS	4,160 VOLTS R.E./HLAP INCOMING SERVICE	MOTOR CONTROL CENTER #2 FEEDER #2	MOTOR CONTROL CENTER #1 FEEDER #1
<u>.</u> 06						
	•					

4,160V SWITCHGEAR No. 1

SCALE: 3/4" = 1'- 0"

4,160 VOLT CONNECTED LOAD ANALYSIS

	A	B	
1 - 300 H.P. MOTOR @ 39.0 AMPS =	39.0	39.0	39.0 AMPS
4 - 500 H.P. MOTORS @ 63.0 AMPS EA. =	252.0	252.0	252.0 AMPS
1 - 750 KVA TRANSF. FEEDER =	104.1	0.0	104.1 AMPS
25% OF LARGEST MOTOR APPROX=	24.3		24.3 AMPS
TOTAL	419.4	315.3	419.4

NOTES:

- FOR DESCRIPTION AND RATINGS OF ITEMS INDICATED WITH ROMAN NUMERAL FLAGS, SEE DEVICE RATINGS SCHEDULE ON THIS
- SEE SHEET E-7 FOR CONDUIT SCHEDULES, RACEWAY AND WIRE SIZES. SEE RELATED SPECIFICATIONS FOR REQUIRED CONDUIT AND WIRE INSULATION TYPES.

DOCUMENT IS FOR INTERIM REVIEW AND NOT INTENDED FOR CONSTRUCTION, BIDDING, OR PERMIT PURPOSES

MICHAEL H. WOOLEY

40433 TEXAS SERIAL NO.

DECEMBER 2009 DATE

PRIVATE UTILITY LINES SHOWN

N/A CENTER POINT/GAS

N/A SBC CO. VALID FOR ONE YEAR APPROVED ONLY FOR UNDERGROUND CONDUIT FACILITIES UNLESS NOTED.

N/A
CENTER POINT/ELECTRIC
APPROVED ONLY FOR CROSSING UNDERGROUND DUCTLINES
UNLESS NOTED. VALID AT TIME OF REVIEW ONLY.

N/A CABLE COMPANY

CDM

APPROVED:

DATE: DECEMBER 2009 MW DESIGNED BY: MW DRAWN BY: JG

KGI Kalluri Group, Inc.
Continto Lobert & Project Memograt
1987 Republishes No. 1-648
10497 Town & Country Way, Suite 220
Houston, Teras 77024
Phone: (713)-365-9288

THIS DOCUMENT IS RELEASED FOR THE PURPOSE OF REVEW UNDER THE AUTHORITY OF MICHAEL H. WOOLEY REGISTERED NO. 40433 DECAMER 16, 2009 IT IS NOT TO BE USED FOR CONSTRUCTION, BIDDING OR PERMIT PURPOSES.

SURVEYED BY: CB

FB NO. 2004-46

CITY OF HOUSTON DEPARTMENT OF PUBLIC WORKS AND ENGINEERING


KATY ADDICKS RE-PUMP STATION BOOSTER PUMP ADDITION


4,160 V INCOMING SERVICE ONE LINE DIAGRAM, DEVICE RATING SCHEDULE AND LOAD ANALYSIS

ELECTRICAL

WARNING 0 1	WBS NO. S-001000-0027-3						
THIS BAR DOES NOT MEASURE 1"	DRAWING SCALE						
HEN DRAWING IS NOT TO SCALE	NO SCALE						
DWG NO	CITY OF HOUSTON PM						
E-3	JOHN MSIGWA, P.E.						
	SHEET NO OF						

\* - DENOTES EXISTING

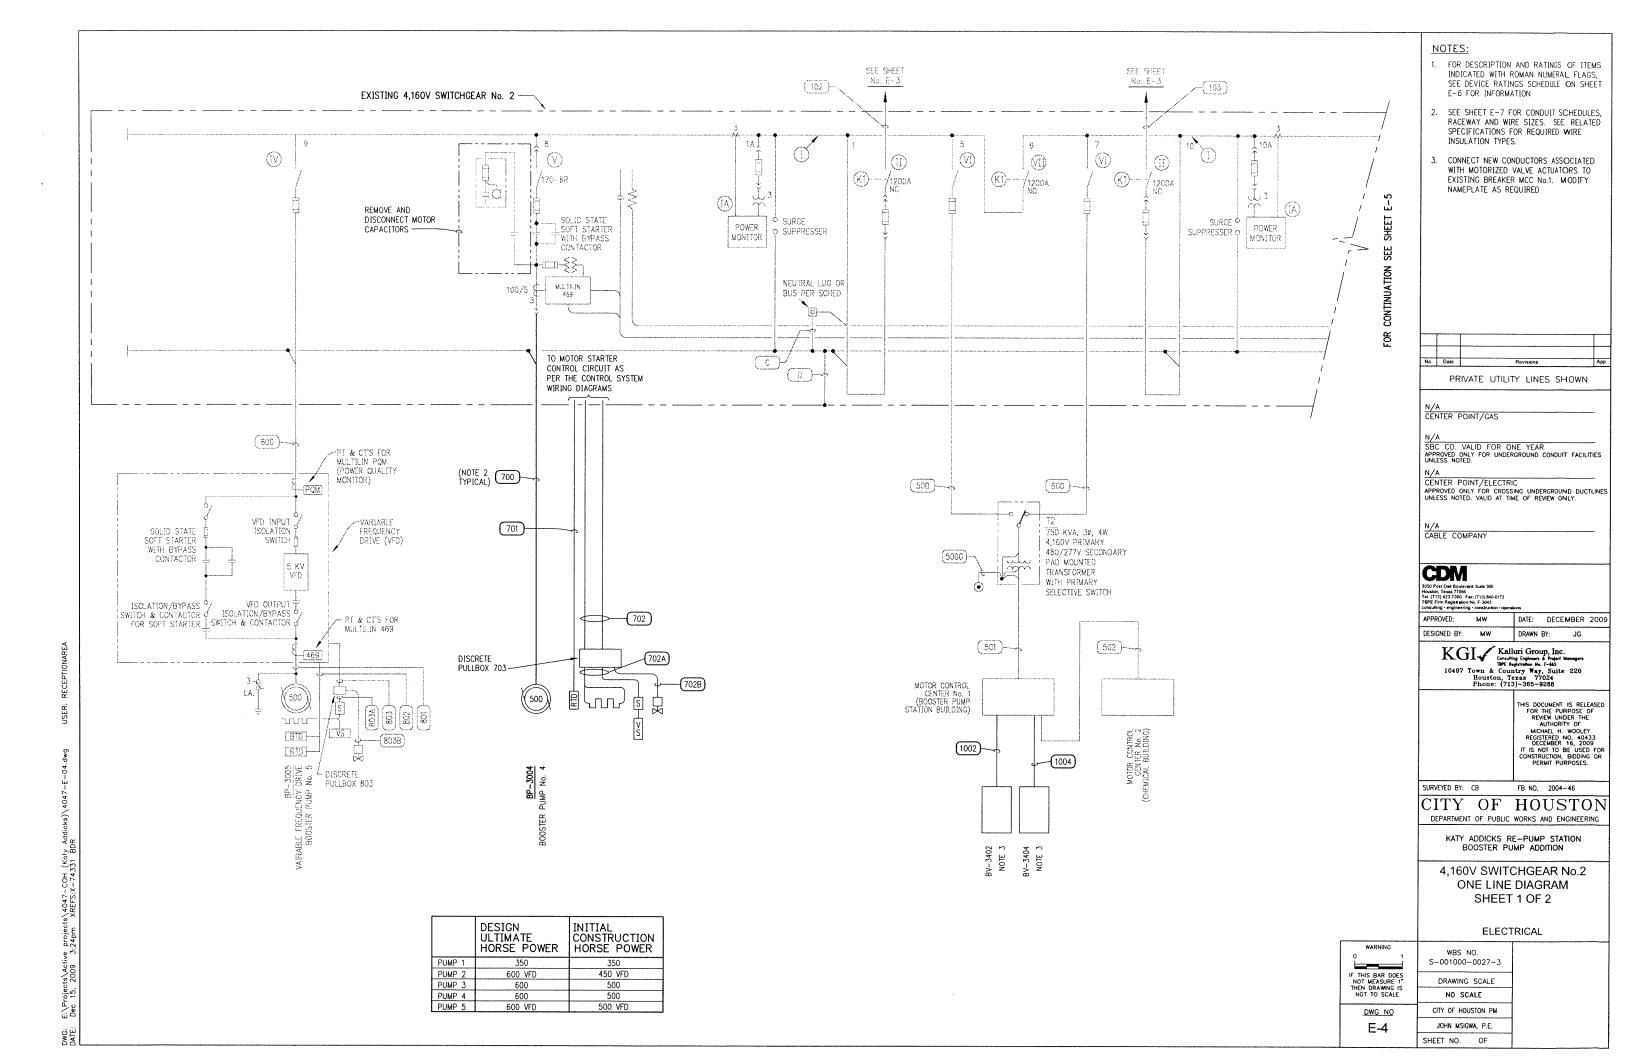

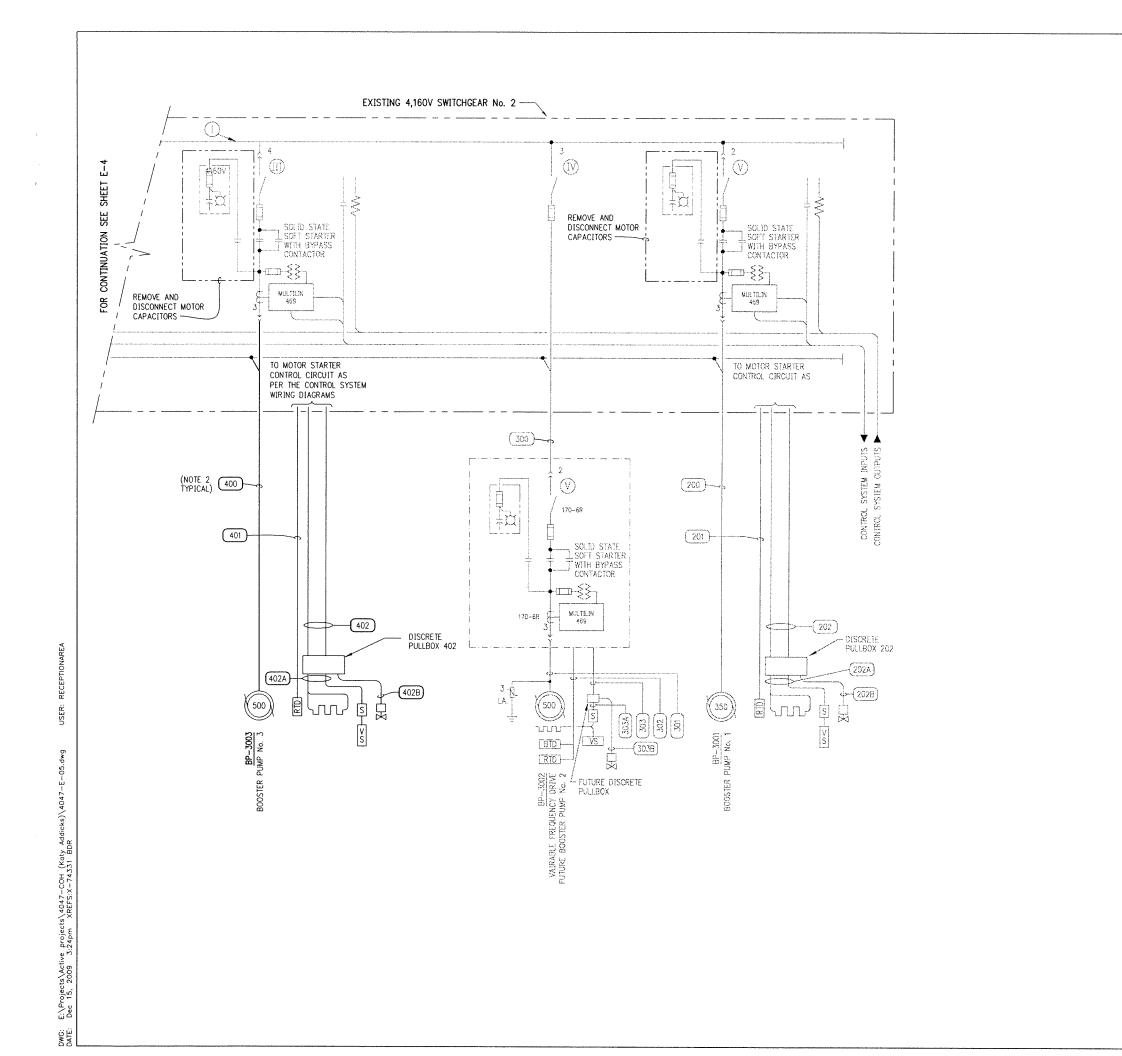

NOTES:

- FOR DESCRIPTION AND RATINGS OF ITEMS INDICATED WITH ROMAN NUMERAL FLAGS, SEE DEVICE RATINGS SCHEDULE ON SHEET E-6 FOR INFORMATION.
- SEE RELATED CONDUIT SCHEDULES FOR RACEWAY AND WIRE SIZES. SEE RELATED SPECIFICATIONS FOR REQUIRED WIRE INSULATION TYPES.

		+-
ale	Revisions	Арр.
PR	IVATE UTILITY LINES SHOWN	

N/A CENTER POINT/GAS

N/A SBC CO. VALID FOR ONE YEAR APPROVED ONLY FOR UNDERGROUND CONDUIT FACILITIES UNLESS NOTED.

N/A
CENTER POINT/ELECTRIC
APPROVED ONLY FOR CROSSING UNDERGROUND DUCTLINES
UNLESS NOTED. VALID AT TIME OF REVIEW ONLY.

N/A CABLE COMPANY

## CDM

APPROVED: MW DATE: DECEMBER 2009 DESIGNED BY: MW DRAWN BY:

KGI Kalluri Group, Inc. Constitu Gebera & reject Mesogers BR Heighton to, 1-185 10497 Town & Country Way, Suite 220 Houston, Texas 77024 Phone: (713)-365-9286

I'MIS DOCUMENT IS RELEASED FOR THE PURPOSE OF REVIEW UNDER THE AUTHORITY OF MICHAEL H. WOOLEY REGISTERED NO. 40433 DECEMBER 16, 2009 IT IS NOT TO BE USED FOR CONSTRUCTION, BIDDING OR PERMIT PURPOSES.

SURVEYED BY: CB FB NO. 2004-46

## CITY OF HOUSTON DEPARTMENT OF PUBLIC WORKS AND ENGINEERING

KATY ADDICKS RE-PUMP STATION BOOSTER PUMP ADDITION

4,160V SWITCHGEAR No.2 ONE LINE DIAGRAM SHEET 2 OF 2

ELECTRICAL

	1
WARNING 0 1	WBS NO. S-001000-0027-3
IF THIS BAR DOES NOT MEASURE 1" THEN DRAWING IS	DRAWING SCALE
NOT TO SCALE	NO SCALE
DWG NO	CITY OF HOUSTON PM
E-5	JOHN MSIGWA, P.E.
	SHEET NO. OF

1 10	CURRENT RATING NEUTRAL SIZE & TYPE BUS BRACING  POWER MONITOR  VOLTAGE RATING CT RATIO TYPE  SWITCHGEAR MAIN SWITCHES WITH KIRK KEYS  QUANTITY 3 POLE — TYPE MOUNTING VOLTAGE RATING FRAME SIZE CONTINUOUS FUSE SIZE INTERRUPT CAPACITY OPTIONS  JSO H.P. BOOSTER PUMP	1200A NONE 50KA SYM  4160V 1200 : 5 SOLID STATE  2 LOAD BREAK FIXED 5 KV 1200A 600A 50KA SYM NORMALLY CLOS
	BUS BRACING  POWER MONITOR  VOLTAGE RATING  CT RATIO  TYPE  SWITCHGEAR MAIN SWITCHES WITH KIRK KEYS  QUANTITY  3 POLE — TYPE  MOUNTING  VOLTAGE RATING  FRAME SIZE CONTINUOUS  FUSE SIZE  INTERRUPT CAPACITY  OPTIONS  JSO H.P. BOOSTER PUMP	2 LOAD BREAK FIXED 5 KV 1200A 600A 50KA SYM
	BUS BRACING  POWER MONITOR  VOLTAGE RATING  CT RATIO  TYPE  SWITCHGEAR MAIN SWITCHES WITH KIRK KEYS  QUANTITY  3 POLE — TYPE  MOUNTING  VOLTAGE RATING  FRAME SIZE CONTINUOUS  FUSE SIZE  INTERRUPT CAPACITY  OPTIONS  JSO H.P. BOOSTER PUMP	4160V 1200 : 5 SOLID STATE 2 LOAD BREAK FIXED 5 KV 1200A 600A 50KA SYM
	VOLTAGE RATING CT RATIO TYPE  SWITCHGEAR MAIN SWITCHES WITH KIRK KEYS QUANTITY 3 POLE — TYPE MOUNTING VOLTAGE RATING FRAME SIZE CONTINUOUS FUSE SIZE INTERRUPT CAPACITY OPTIONS JSO H.P. BOOSTER PUMP	1200 : 5 SOLID STATE  2 LOAD BREAK FIXED 5 KV 1200A 600A 50KA SYM
	VOLTAGE RATING CT RATIO TYPE  SWITCHGEAR MAIN SWITCHES WITH KIRK KEYS QUANTITY 3 POLE — TYPE MOUNTING VOLTAGE RATING FRAME SIZE CONTINUOUS FUSE SIZE INTERRUPT CAPACITY OPTIONS JSO H.P. BOOSTER PUMP	1200 : 5 SOLID STATE  2 LOAD BREAK FIXED 5 KV 1200A 600A SOKA SYM
	CT RATIO TYPE  SWITCHGEAR MAIN SWITCHES WITH KIRK KEYS  QUANTITY 3 POLE — TYPE MOUNTING VOLTAGE RATING FRAME SIZE CONTINUOUS FUSE SIZE INTERRUPT CAPACITY OPTIONS  JSO H.P. BOOSTER PUMP	1200 : 5 SOLID STATE  2 LOAD BREAK FIXED 5 KV 1200A 600A 50KA SYM
	TYPE SWITCHGEAR MAIN SWITCHES WITH KIRK KEYS QUANTITY 3 POLE — TYPE MOUNTING VOLTAGE RATING FRAME SIZE CONTINUOUS FUSE SIZE INTERRUPT CAPACITY OPTIONS JSO H.P. BOOSTER PUMP	2 LOAD BREAK FIXED 5 KV 1200A 600A 50KA SYM
	WITH KIRK KEYS  QUANTITY  3 POLE — TYPE  MOUNTING  VOLTAGE RATING  FRAME SIZE CONTINUOUS  FUSE SIZE  INTERRUPT CAPACITY  OPTIONS  JSO H.P. BOOSTER PUMP	LOAD BREAK FIXED 5 KV 1200A 600A SOKA SYM
	WITH KIRK KEYS  QUANTITY  3 POLE — TYPE  MOUNTING  VOLTAGE RATING  FRAME SIZE CONTINUOUS  FUSE SIZE  INTERRUPT CAPACITY  OPTIONS  JSO H.P. BOOSTER PUMP	LOAD BREAK FIXED 5 KV 1200A 600A SOKA SYM
	3 POLE — TYPE MOUNTING VOLTAGE RATING FRAME SIZE CONTINUOUS FUSE SIZE INTERRUPT CAPACITY OPTIONS JSO H.P. BOOSTER PUMP	LOAD BREAK FIXED 5 KV 1200A 600A 50KA SYM
	MOUNTING VOLTAGE RATING FRAME SIZE CONTINUOUS FUSE SIZE INTERRUPT CAPACITY OPTIONS JSO H.P. BOOSTER PUMP	FIXED 5 KV 1200A 600A 50KA SYM
	VOLTAGE RATING FRAME SIZE CONTINUOUS FUSE SIZE INTERRUPT CAPACITY OPTIONS JSO H.P. BOOSTER PUMP	5 KV 1200A 600A 50KA SYM
	FRAME SIZE CONTINUOUS FUSE SIZE INTERRUPT CAPACITY OPTIONS JSO H.P. BOOSTER PUMP	1200A 600A 50KA SYM
	FUSE SIZE INTERRUPT CAPACITY OPTIONS JSO H.P. BOOSTER PUMP	600A 50KA SYM
	INTERRUPT CAPACITY OPTIONS 350 H.P. BOOSTER PUMP	SOKA SYM
	OPTIONS  350 H.P. BOOSTER PUMP	
	350 H.P. BOOSTER PUMP	NORMALLY CLOS
		4
		4
	SOLID STATE SOFT START	
	MCTOR STARTER	
	QUANTITY	1
	MOUNTING	DRAWOUT
	SHORT CIRCUIT PROTECTION	
	3 POLE - TYPE	FUSE
	VOLTAGE RATING	5 KV
	FRAME SIZE	400A
4	FUSE SIZE	2R70A
	INTERRUPT CAPACITY	50KA SYM
	MOTOR STARTING CONTACTOR	
	3 POLE - TYPE	FIXED
	VOLTAGE RATING	5 KV
	SIZE/CURRENT RATING	400A
	OVERLOAD PROTECTION	1.7.7.77
		MULTILIN 469
		100 : 5
	4	3 POLE - TYPE VOLTAGE RATING FRAME SIZE FUSE SIZE INTERRUPT CAPACITY MOTOR STARTING CONTACTOR 3 POLE - TYPE VOLTAGE RATING

4,160 VOLT SWITCHGEAR No. 2 DEVICE RATING SCHEDULE

DESCRIPTION

SWITCHOEAR MAIN BUS VOLTAGE RATING

CIRCUIT

RATINGS FOR PUMP SIZES INDICATED

4,	4,160 VOLT SWITCHGEAR No. 2 DEVICE RATING SCHEDULE						
ITEM	CIRCUIT	DESCRIPTION					
		500 H.P. BOOSTER PUMP YFD DRIVE FEEDER SWIICH					
		QUANTITY					
(IV)		3 POLE - TYPE	LOAD BREAK				
	9	MOUNTING	FIXED				
1		VOLTAGE RATING	5 KV				
		FRAME SIZE CONTINUOUS FUSE SIZE	400A 150F				
		INTERRUPT CAPACITY	50KA SYM				
		OPTIONS	70/V1 518				
		500 H.P. BOOSTER SOLID STATE SOFT START MOTOR STARTERS					
		QUANTITY	2				
		MOUNTING	DRAWOUT				
		SHORT CIRCUIT PROTECTION					
		3 POLE - TYPE	FUSED				
		VOLTAGE RATING	5 KV				
	*2	FRAME SIZE	400A				
(v)	+8	FUSE SIZE INTERRUPT CAPACITY	3R-100A				
_	3		50KA SYM				
		MOTOR STARTING CONTACTOR					
		3 POLE - TYPE	FIXED				
		VOLTAGE RATING	5 KV				
		SIZE/CURRENT RATING	400A				
		OVERLOAD PROTECTION	MULTILIN				
		TYPE	469				
		CT RATIO	100 ; 5				

•	_	 			
	*	 DENOTES	<b>EXISTING</b>	MOTOR	STARTER

4,	,160 VOLT DEVICE I	RATINGS FOR PUMP SIZES INDICATED	
ITEM	CIRCUIT	DESCRIPTION	
VI	5 7	12 TRANSFORMER FEEDER SWITCHES QUANTITY 3 POLE — TYPE MOUNTING VOLTAGE RATING FRAME SIZE CONTINUOUS FUSE SIZE INTERRUPT CAPACITY OPTIONS	2 LOAD BREAK FIXED 5 KV 1200A 200E 50KA SYM
(VII)	6	SWITCHGEAR TIE SWITCH WITH KIRK KEY  3 POLE - TYPE MOUNTING VOLTAGE RATING FRAME SIZE CONTINUOUS FUSE SIZE INTERRUPT CAPACITY OPTIONS	LOAD BREAK FIXED 5 KV 1200A NO FUSE 50KA SYM NORMALLY OPEN

36"	36"	36"	36"	36"	36"	36"	36"	36"	36"	36"	J
9P-3005 800STER PUMP NO. 5 500 HP VFD	BP-3004 BOOSTER PUMP NO. 4 500 HP	TZ TRANSFORMER FEEDER SWITCH NO. 2	<u>MAIN SWITCH</u>	<u>TIE SWITCH</u>	<u>AUXILTARY</u>	MAIN SWITCH	T2 TRANSFORMER FEEDER SWITCH NO. 1	BP-3003 BOOSTER PUMP NO. 3 500 HP	BP-3002 B00STER PUMP NO. 2 500 HP VFD	<u>BP-3001</u> BOOSTER PUMP NO. 1 350 HP	
V+ U									VFD FUTURE		
											.06

4" CONCRETE PAD

IF THIS BAR DOES NOT MEASURE 1" THEN DRAWING IS NOT TO SCALE

WBS NO. S-001000-0027-3 DRAWING SCALE

SHEET NO. OF

PRIVATE UTILITY LINES SHOWN

N/A
SBC CO. VALID FOR ONE YEAR
APPROVED ONLY FOR UNDERGROUND CONDUIT FACILITIES
UNLESS NOTED.

N/A
CENTER POINT/ELECTRIC
APPROVED ONLY FOR CROSSING UNDERGROUND DUCTLINES
UNLESS NOTED. VALID AT TIME OF REVIEW ONLY.

DATE: DECEMBER 2009

THIS DOCUMENT IS RELEASED FOR THE PURPOSE OF REVIEW UNDER THE AUTHORITY OF MICHAEL H. WOOLEY REGISTERED NO. 40433 DECEMBER 16, 2009 IT IS NOT TO BE USED FOR CONSTRUCTION, BIDDING OR PERMIT PURPOSES.

FB NO. 2004-46

DRAWN BY:

KGI Kalluri Group, Inc.
Comming Explain a Project Managers
THE Replands in A 1-848

10497 Town & Country Way, Suite 220
Houston, Texas 77024
Phone: (713)-365-9288

CITY OF HOUSTON DEPARTMENT OF PUBLIC WORKS AND ENGINEERING KATY ADDICKS RE-PUMP STATION BOOSTER PUMP ADDITION

4,160V SWITCHGEAR No.2 DEVICE RATING SCHEDULE AND ELEVATION

ELECTRICAL

N/A CENTER POINT/GAS

N/A CABLE COMPANY

**CDM** 

APPROVED:


DESIGNED BY: MW


SURVEYED BY: CB

NO SCALE CITY OF HOUSTON PM DWG NO JOHN MSIGWA, P.E. E-6

4,160V SWITCHGEAR No. 2 ELEVATION

SCALE: 3/4" = 1'- 0" 90"H X 36"W X 30"D EA. SECTION

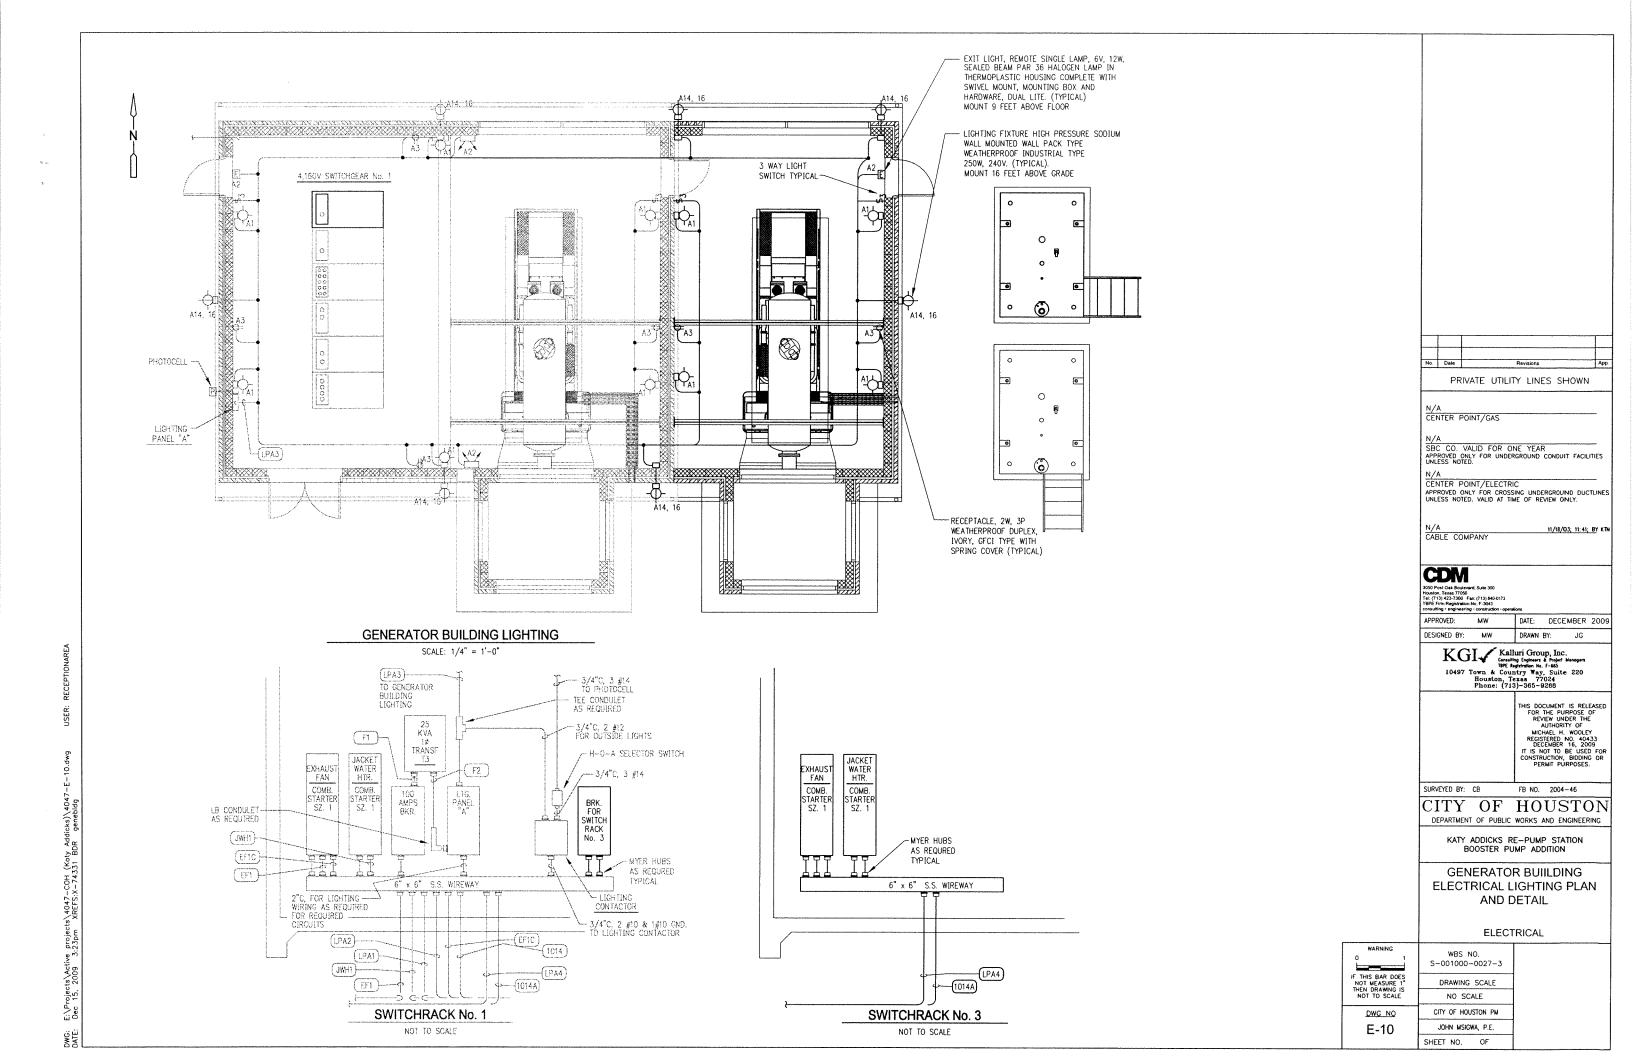

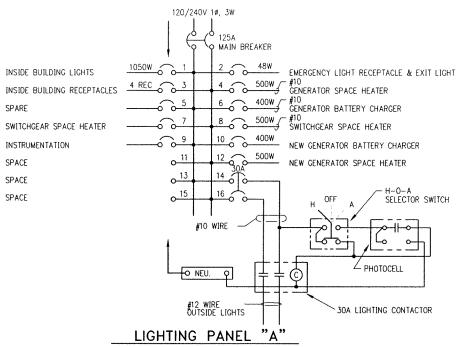


ALL BREAKERS 20AMP S.P. UNLESS SHOWN OTHER WISE (GENERATOR BUILDING)

## LIGHTING PANEL "A" LOAD ANALYSIS

INSIDE LIGHTS  1,140 SQ FT @ 2 VA = 2,280 VA OR  ACTUAL CONNECTED 6 x 175W x 1.25 = 1312.5 VA	=	2,280	VA
OUTSIDE LIGHTS 4 x 250W x 1.25	=	1,250	VA
4 RECEPTACLES @ 180 VA EACH	==	720	VA
EMERGENCY AND EXIT LIGHTS	=	48	VA
2 GENERATOR SPACE HEATERS @ 500W	=	1,000	VA
2 GENERATOR BATTERY CHARGER @ 400W	=	800	VA
SWITCHGEAR SPACE HEATER @ 500W	=	500	VA
INSTRUMENTATION @ 500W	=	500	VA
TOTAL LOAD	=	7,098	VA

USE 25 KVA TRANSFORMER 25 KVA @ 240V., 1ø = 104 AMPS USE 125 AMP MAIN BREAKER

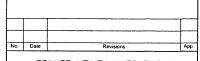

PRIVATE UTILITY LINES SHOWN

N/A CENTER POINT/GAS

N/A SBC CO. VALID FOR ONE YEAR APPROVED ONLY FOR UNDERGROUND CONDUIT FACILITIES UNLESS NOTED.

CENTER POINT/ELECTRIC
APPROVED ONLY FOR CROSSING UNDERGROUND DUCTLINES
UNLESS NOTED. VALID AT TIME OF REVIEW ONLY.

N/A CABLE COMPANY

CDM

APPROVED: DATE: DECEMBER 2009 DESIGNED BY: MW DRAWN BY: JG

KGI Kalluri Group, Inc.
Consulting Explaint & Project Monogers
THE Reportation to, 1-68.

10497 Town & Country Way, Suite 220
Houston, Texas 77024
Phone: (713)-365-9288

THIS DOCUMENT IS RELEASED FOR THE PURPOSE OF REVIEW UNDER THE AUTHORITY OF MICHAEL IN WOOLEY REGISTERED NO. 40433 DECEMBER 16, 2009 IT IS NOT TO BE USED FOR CONSTRUCTION, BIDDING OR PERMIT PURPOSES.


SURVEYED BY: CB FB NO. 2004-46


CITY OF HOUSTON DEPARTMENT OF PUBLIC WORKS AND ENGINEERING


KATY ADDICKS RE-PUMP STATION BOOSTER PUMP ADDITION


LIGHTING PANELS SCHEDULES

ELECTRICAL

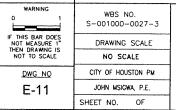

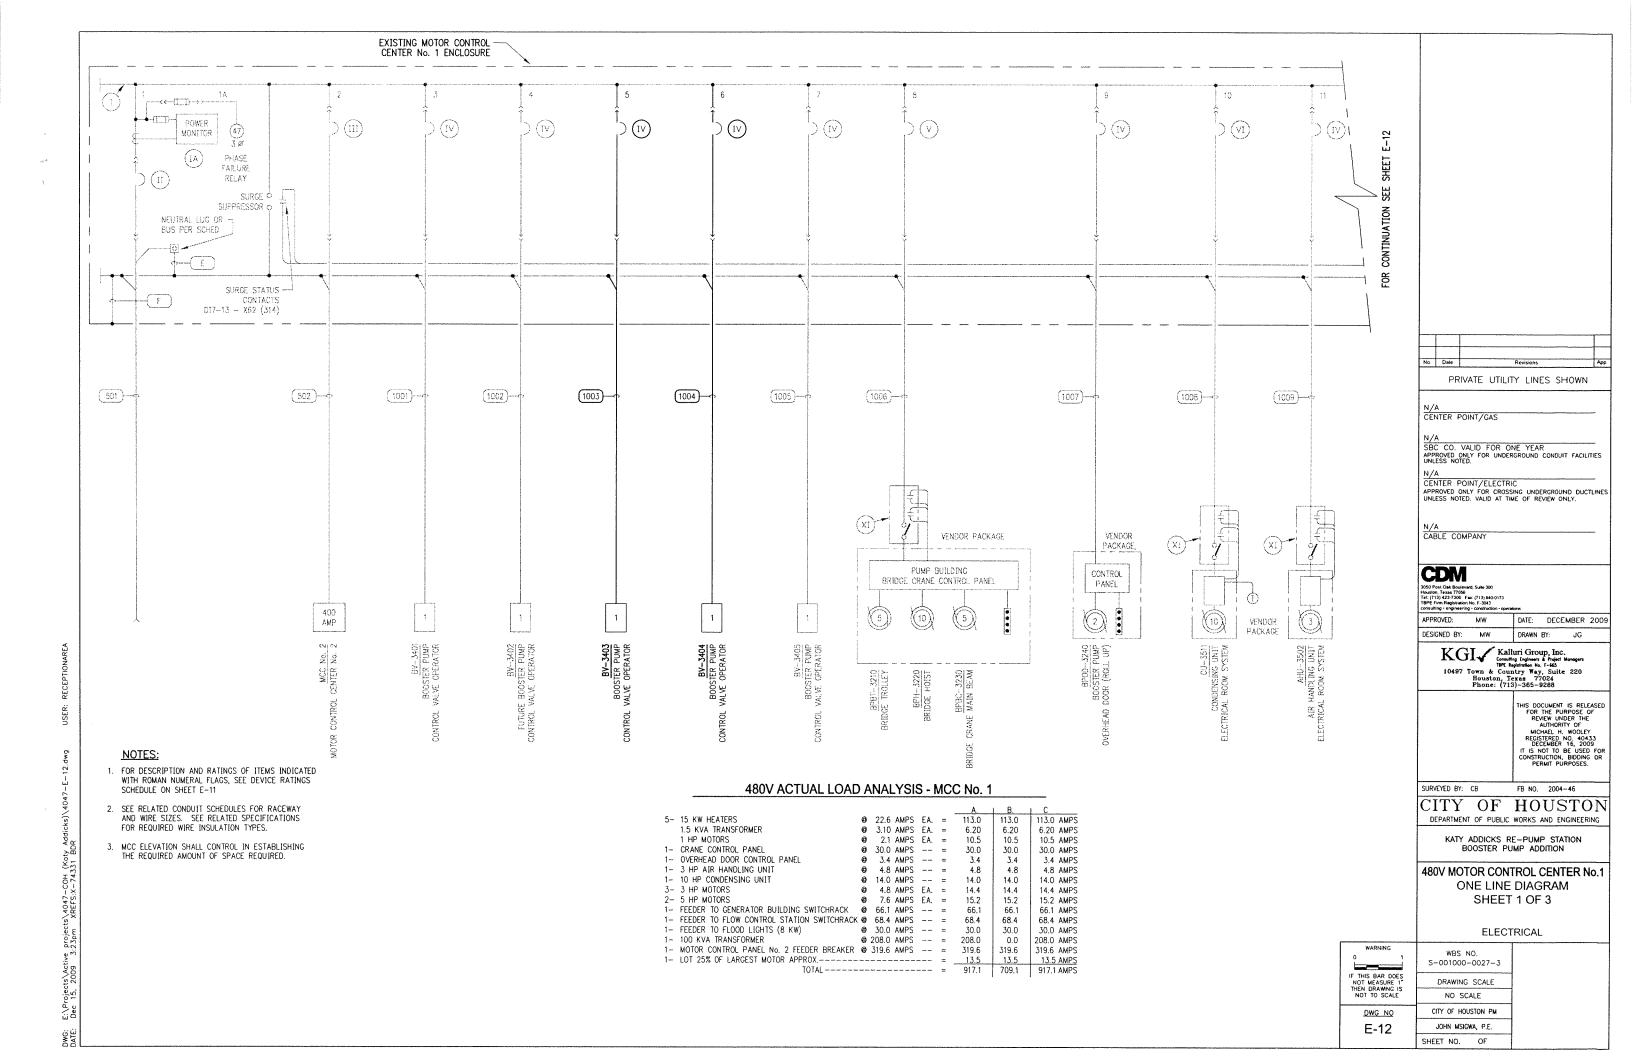

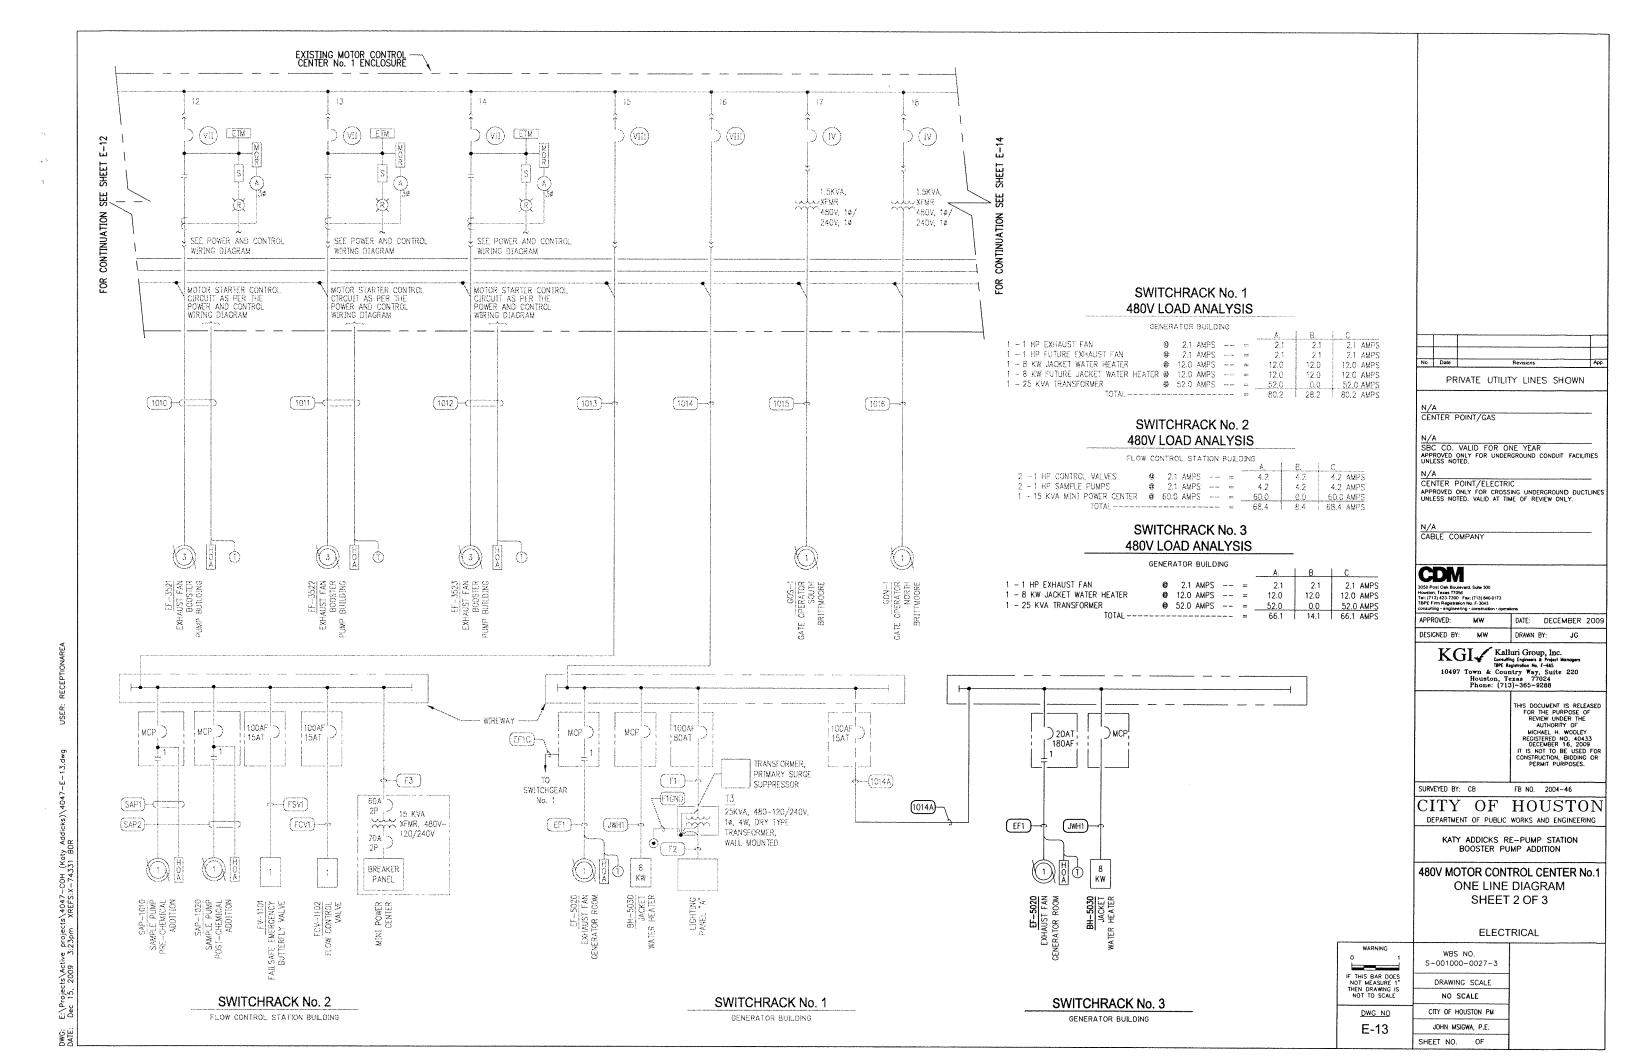

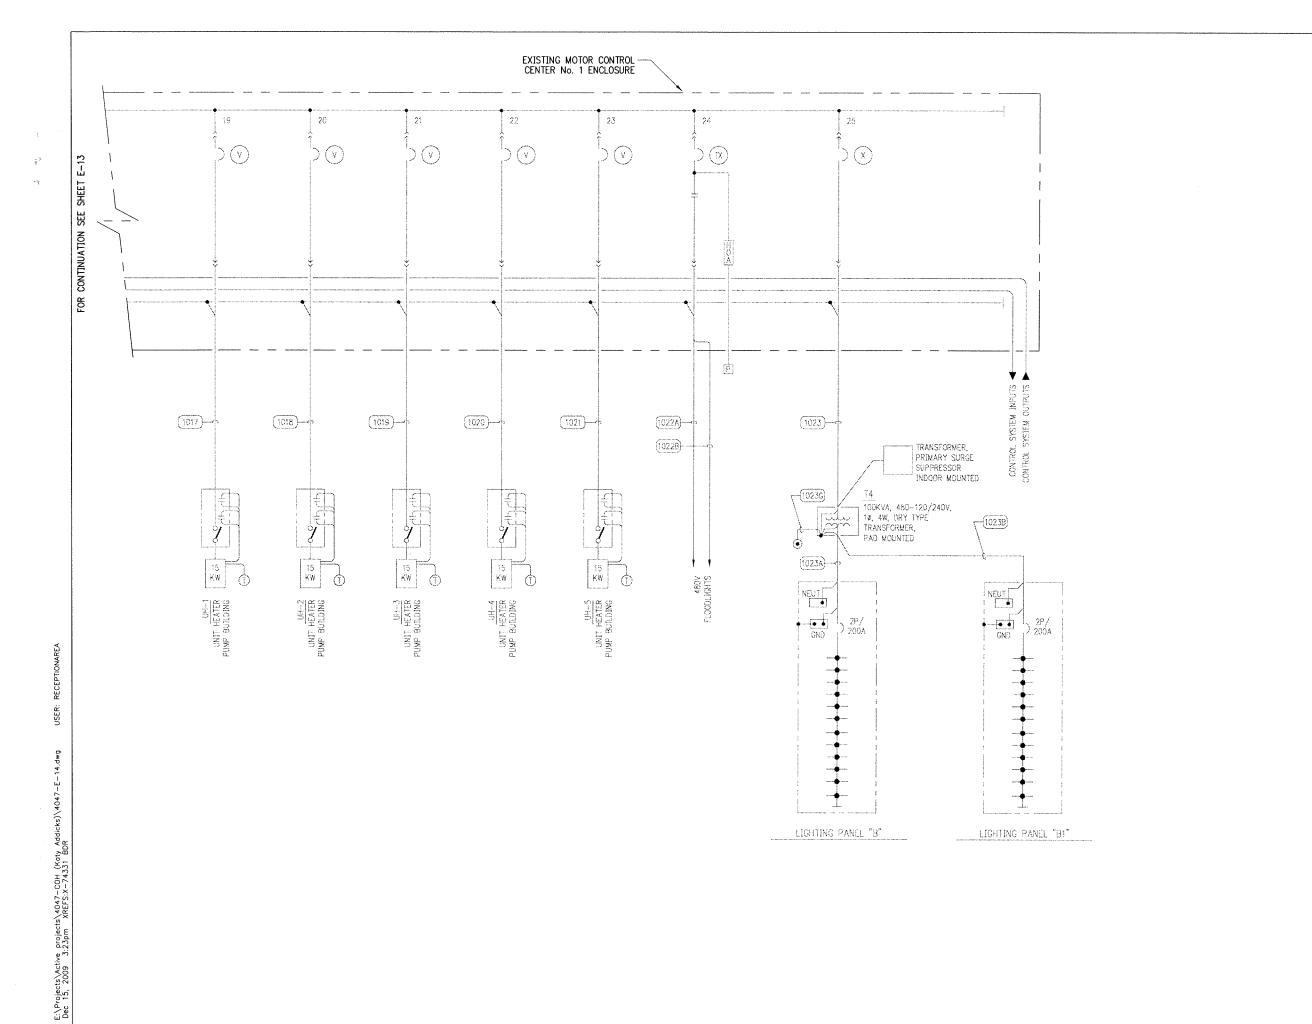

PRIVATE UTILITY LINES SHOWN

N/A CENTER POINT/GAS

N/A SBC CO, VALID FOR ONE YEAR APPROVED ONLY FOR UNDERGROUND CONDUIT FACILITIES UNLESS NOTED.

N/A
CENTER POINT/ELECTRIC
APPROVED ONLY FOR CROSSING UNDERGROUND DUCTLINES
UNLESS NOTED. VALID AT TIME OF REVIEW ONLY.

N/A CABLE COMPANY

CDPW 3050 Post Oak Boulevard, Sufe 300 Mouston, Teass 77056 Tel: (713) 422-7300 Fax: (713) 840-0173 TBPE Firm Registration No. F-3043 consulting - engineering - construction - oper

APPROVED: MW DATE: DECEMBER 2009

DESIGNED BY: MW DRAWN BY: JG

KGI Kalluri Group, Inc.
Consulting Engineers & Project Monogers
THE Respiration to, 1-645
10497 Town & Country Way, Suite 220
Rouston, Texas 77024
Phone: (713)-365-9288

THIS DOCUMENT IS RELEASED FOR THE PURPOSE OF REVIEW UNDER THE AUTHORITY OF MICHAEL H. WOOLEY RECISTERED NO. 40433 DECEMBER 16, 2009 IT IS NOT TO BE USED FOR CONSTRUCTION, BIDDING OR PERMIT PURPOSES.

SURVEYED BY: CB FB NO. 2004-46

CITY OF HOUSTON DEPARTMENT OF PUBLIC WORKS AND ENGINEERING

KATY ADDICKS RE-PUMP STATION BOOSTER PUMP ADDITION

480V MOTOR CONTROL CENTER No.1 ONE LINE DIAGRAM SHEET 3 OF 3

**ELECTRICAL** 

WARNING  0 1  IF THIS BAR DOES NOT MEASURE 1* THEN DRAWING IS NOT TO SCALE	WBS NO. S-001000-0027-3	
	DRAWING SCALE	
	NO SCALE	
DWG NO	CITY OF HOUSTON PM	
E-14	JOHN MSIGWA, P.E.	
	SHEET NO. OF	